



BUILDING SITE INFORMATION	
420 WEBSTER AVENUE, QUESNEL, BC	

BUILDING WATER SERVICE PIPING SIZED USING AVERAGE PRESSURE LOSS METHOD			
DESCRIPTION	FIXTURE UNITS	USGPM	LITRES/SECOND
DOMESTIC WATER	61.6	32.48	2.05
TOTAL WATER SERVICE	61.6	32.48	2.05
	-		

BUILDING SANITARY LOAD	
DESCRIPTION	FIXTURE UNITS
BUILDING	61
TOTAL SANITARY SERVICE	61

BUILDING STORM LOAD (BASED ON 10MM/15MIN RAINFALL INTENSITY)		
DESCRIPTION	AREA [m²]	LITRES
BUILDING	282	2,820
SITE	-	-
TOTAL STORM SERVICE	282	2,820
	·	

BUILDING GAS LOAD	
DESCRIPTION	BTU/H
FURNACE, FUR-1	110,000
FURNACE, FUR-2	88,000
HOT WATER TANK, HWT-1	125,000
TOTAL GAS SERVICE	323,000
LENGTH OF PIPE	40 FT
GAS PRESSURE IN BUILDING:	2 PSI

BUILDING ENERGY - MECHANICAL	
HVAC DESIGN	
ENERGY STANDARD/CODE	ASHRAE 90.1-2016
COMPLIANCE PATH	PRESCRIPTIVE
DESIGN METHOD	MANDATORY PROVISIONS & PRESCRIPTIVE
IN ACCORDANCE WITH	SECTION 6
CLIMATE ZONE	5
VENTILATION	ASHRAE 62.1-2001 (EXCEPT ADDENDUM N)

DESIGN METHOD	INANDATORT TROVISIONS & TRESCRIT
IN ACCORDANCE WITH	SECTION 6
LIMATE ZONE	5
TILATION	ASHRAE 62.1-2001 (EXCEPT ADDENDU

GENERAL NOTES:		
1.	INSTALLATIONS SHALL BE IN ACCORDANCE WITH THE BRITISH COLUMBIA BUILDING CODE 2018, BRITISH COLUMBIA PLUMBING CODE 2018, LOCAL BUILDING BYLAWS, MUNICIPAL GUIDELINES AND REQUIREMENTS WHERE APPLICABLE.	
2.	MECHANICAL SERVICES ARE SCHEMATIC REPRESENTATION ONLY. MECHANICAL CONTRACTOR SHALL FIELD MEASURE ALL MATERIAL PRIOR TO INSTALLATION. PROVIDE OFFSETS WHERE NECESSARY TO	

AVOID CONFLICT WITH STRUCTURAL AND ALL OTHER TRADES.

4	2022-06-24	ISSUED FOR TENDER	MW
3	2022-06-17	ISSUED FOR BP / TENDER	MW
2	2021-07-19	ISSUED FOR ELEC COORDINATION	MW
1	2021-07-16	ISSUED FOR REVIEW	MW
No.	DATE	DESCRIPTION	BY
RE\	/ISIONS:		

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202-1339 McGill Road

Kamloops, BC V2C 6K7


SUB-CONSULTANT:

KEYPLAN:

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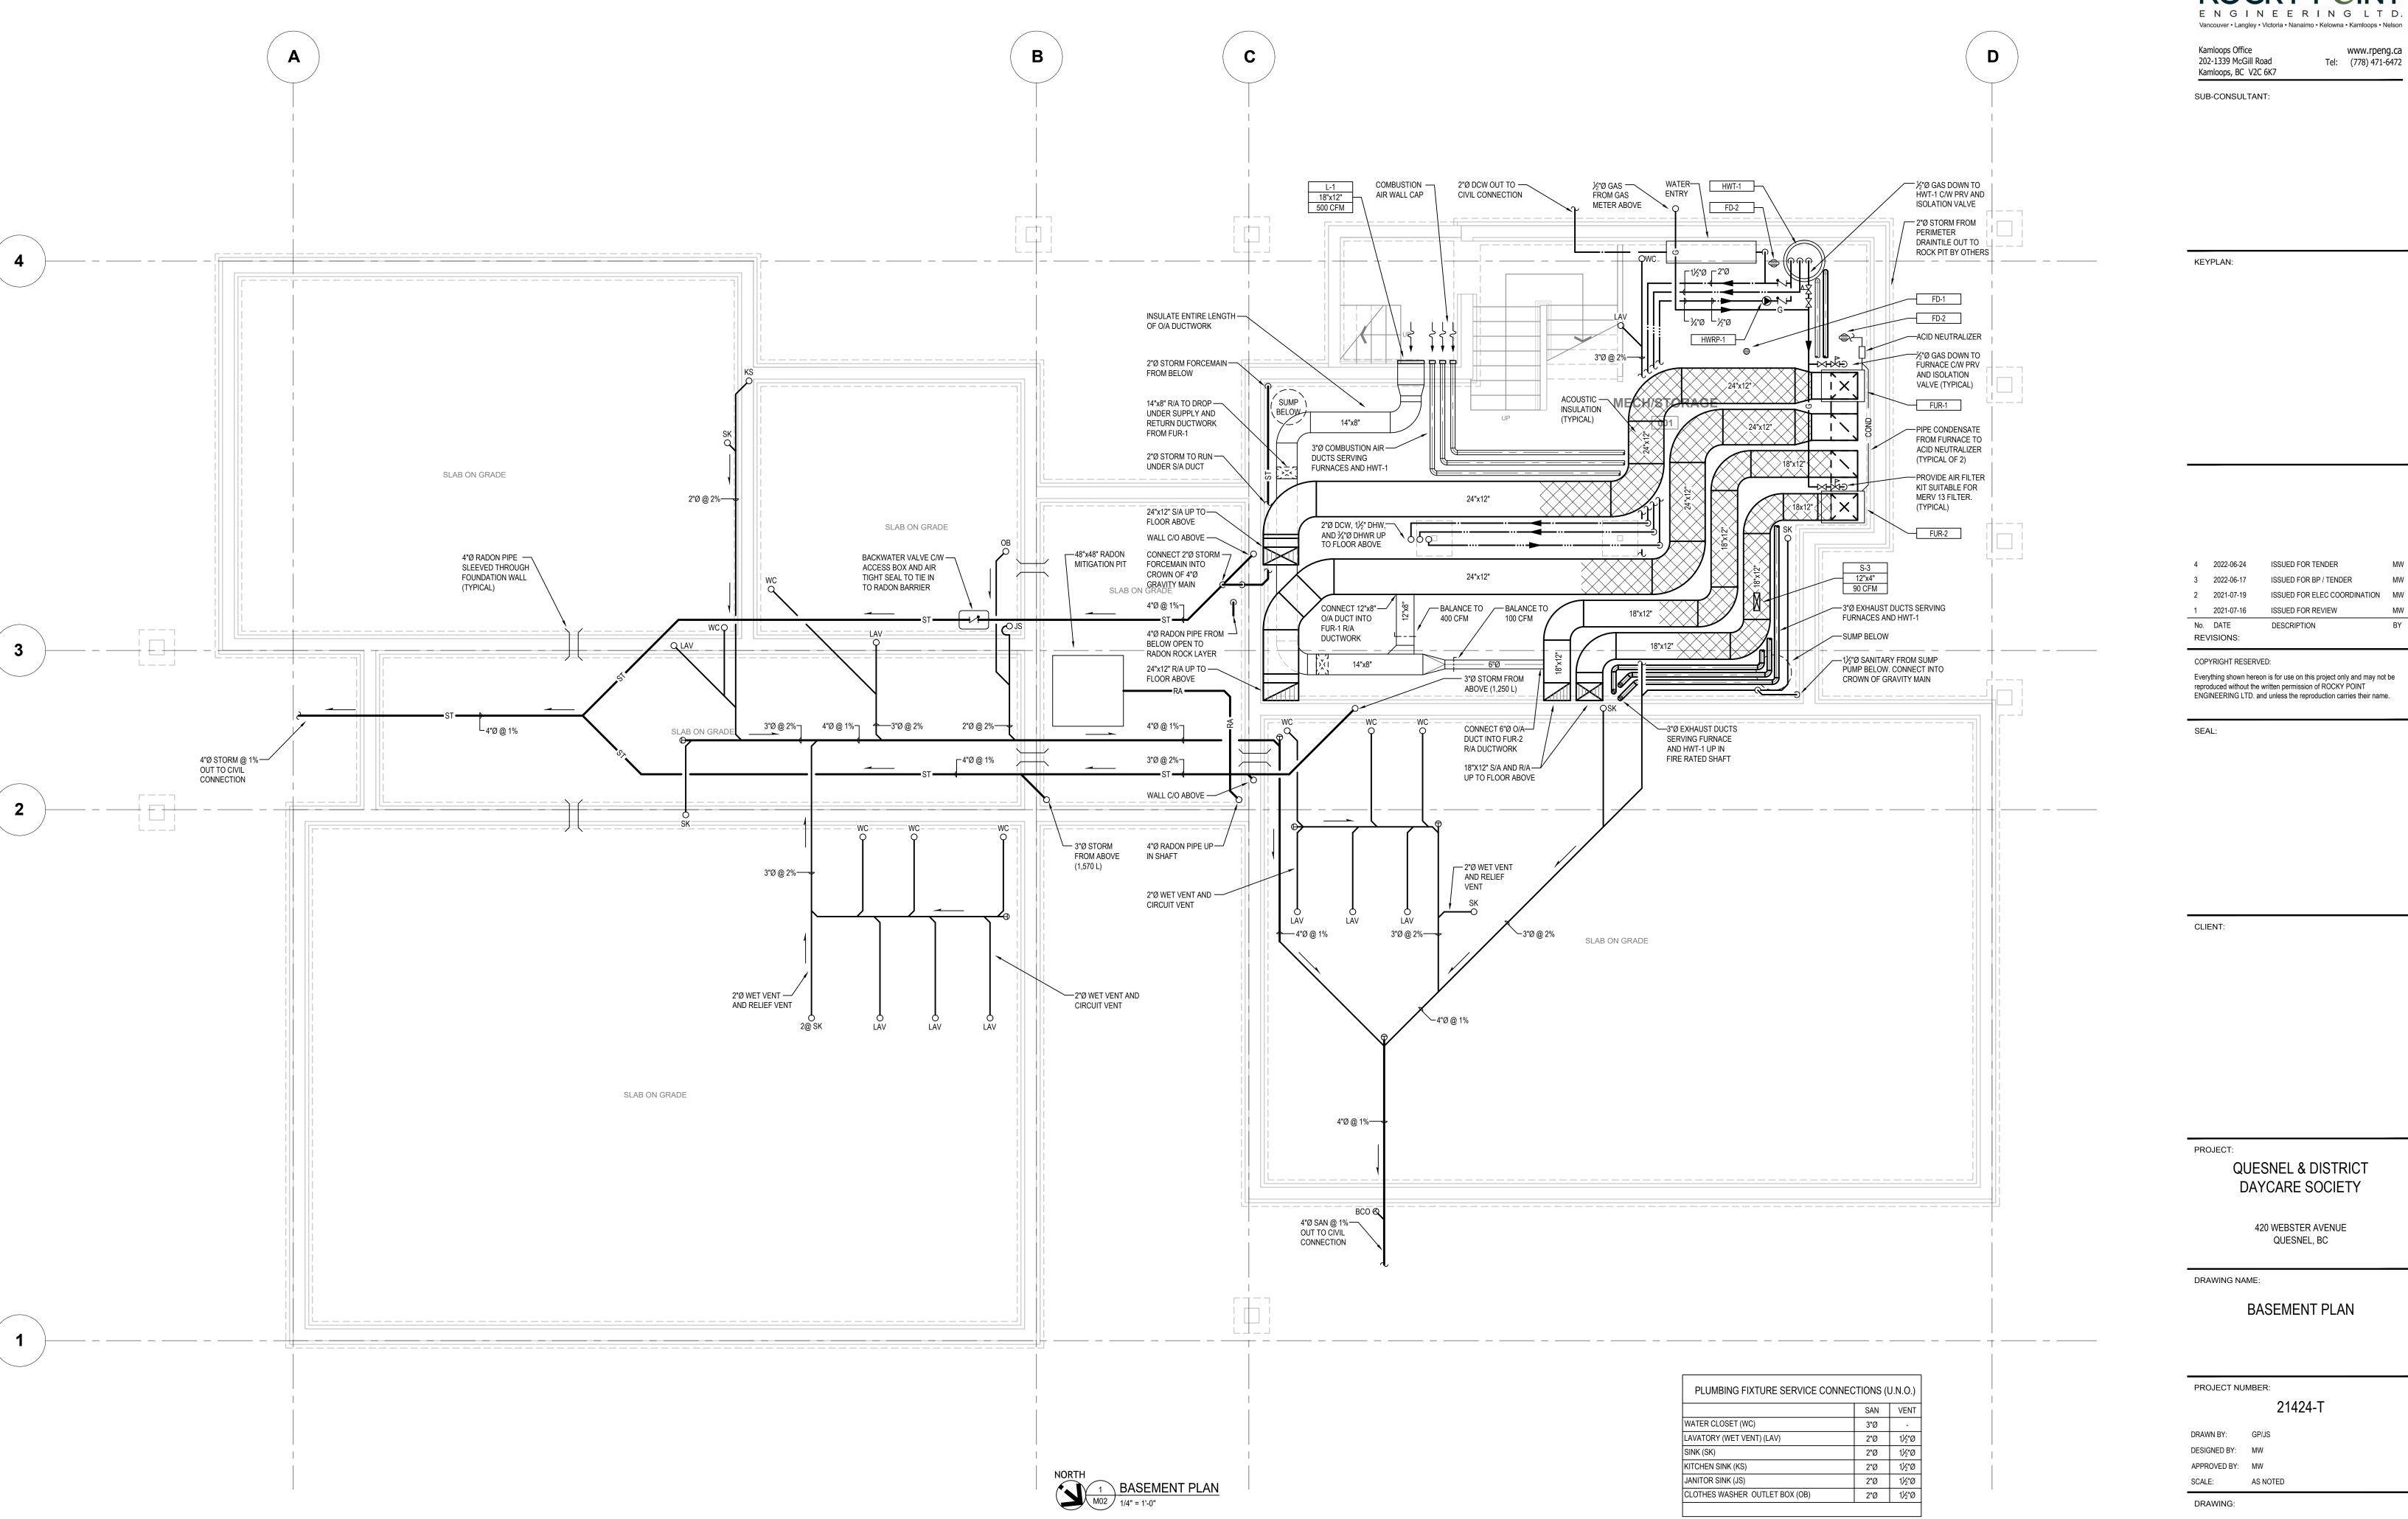
SEAL:

SYMBOL SCHEDULE		
NEW		
	SUPPLY OR OUTDOOR AIR DUCT UP	
CēS	SUPPLY OR OUTDOOR AIR DUCT DOWN	
	RETURN AIR DUCT UP	
653	RETURN AIR DUCT DOWN	
	EXHAUST AIR DUCT UP	
[2]	EXHAUST AIR DUCT DOWN	
	OUTSIDE AIR DUCT UP	
D Z G	OUTSIDE AIR DUCT DOWN	
	TURNING VANES	
<u> </u>	ACOUSTIC INSULATION	
#	BALANCING DAMPER	
B.D.D. O.B.D. AP	BACK DRAFT DAMPER	
O.B.D.	OPPOSED BLADE DAMPER	
AP	ACCESS PANEL	
$\rightrightarrows \rightarrow$	DUCT OR PIPE CAP-OFF	
	SUPPLY AIR DIFFUSER	
\boxtimes	SUPPLY AIR GRILLE	
	EXHAUST AIR GRILLE	
	RETURN AIR GRILLE	
	DOMESTIC COLD WATER (DCW)	
	DOMESTIC HOT WATER (DHW)	
	DOMESTIC HOT WATER RECIRC. (DHWR)	
v	SANITARY VENT	
	SANITARY SEWER	
ST	STORM SEWER	
——— RA ———	RADON	
 1	PIPE CLEAN-OUT	
	PIPE CLEAN-OUT TO GRADE	
—x——x——x—	DRAIN TILE	
——— G ———	NATURAL GAS	
	DIRECTION OF FLOW	
	SLOPE PIPE OR DUCT	
	PIPE DROP	
	PIPE RISE	
	PIPE TEE DOWN	
	PIPE TEE UP	
——————————————————————————————————————	PIPE UNION	
	PIPE REDUCER	
—————————————————————————————————————	GATE VALVE (NORMALLY OPEN)	
———— N.C.	GATE VALVE (NORMALLY CLOSED)	

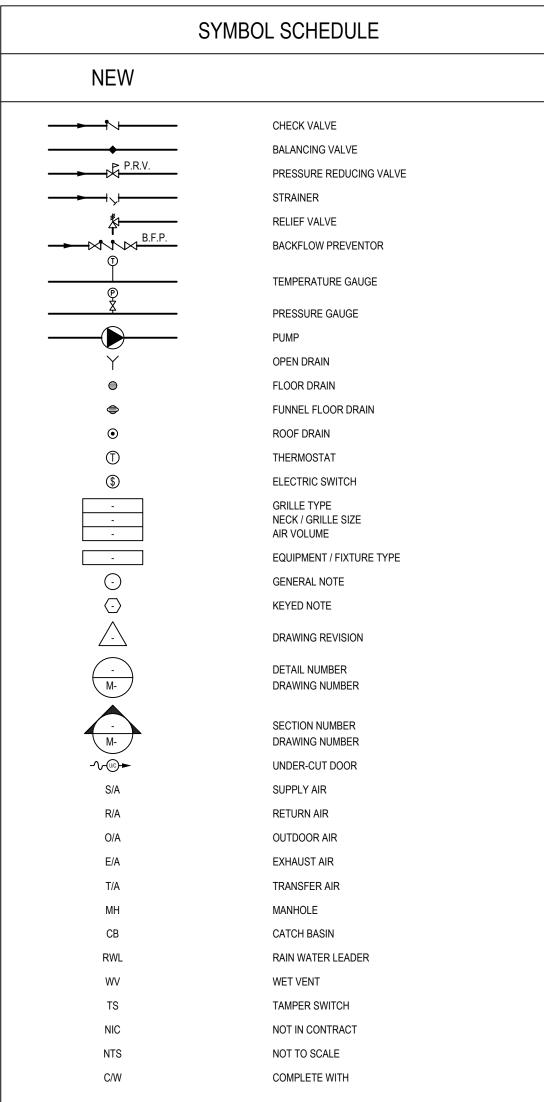

	SYMBOL SCHEDULE
NEW	
-	CHECK VALVE
•	BALANCING VALVE
P.R.V.	PRESSURE REDUCING VALVE
-	STRAINER
\$	RELIEF VALVE
B.F.P.	BACKFLOW PREVENTOR
 	TEMPERATURE GAUGE
<u>Ф</u> Х	PRESSURE GAUGE
	PUMP
Y	OPEN DRAIN
	FLOOR DRAIN
\rightarrow	FUNNEL FLOOR DRAIN
•	ROOF DRAIN
\bigcirc	THERMOSTAT
\$	ELECTRIC SWITCH
- - -	GRILLE TYPE NECK / GRILLE SIZE AIR VOLUME
-	EQUIPMENT / FIXTURE TYPE
<u>-</u>	GENERAL NOTE
<u>-</u>	KEYED NOTE
	DRAWING REVISION
M-	DETAIL NUMBER DRAWING NUMBER
- M-	SECTION NUMBER DRAWING NUMBER
- √ ·uc)►	UNDER-CUT DOOR
S/A	SUPPLY AIR
R/A	RETURN AIR
O/A	OUTDOOR AIR
E/A	EXHAUST AIR
T/A	TRANSFER AIR
MH	MANHOLE
СВ	CATCH BASIN
RWL	RAIN WATER LEADER
WV	WET VENT
TS	TAMPER SWITCH
NIC	NOT IN CONTRACT
NTS	NOT TO SCALE


CLIENT:
PROJECT:
QUESNEL & DISTRICT
DAYCARE SOCIETY
420 WEBSTER AVENUE
QUESNEL, BC
DRAWING NAME:
FOUNDATION PLAN
PROJECT NUMBER:
21424-T
DRAWN BY: GP/JS
DESIGNED BY: MW
APPROVED BY: MW SCALE: AS NOTED
DRAWING:




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ISSUED FOR TENDER 3 2022-06-17 ISSUED FOR BP / TENDER ISSUED FOR ELEC COORDINATION MW ISSUED FOR REVIEW


DAYCARE SOCIETY



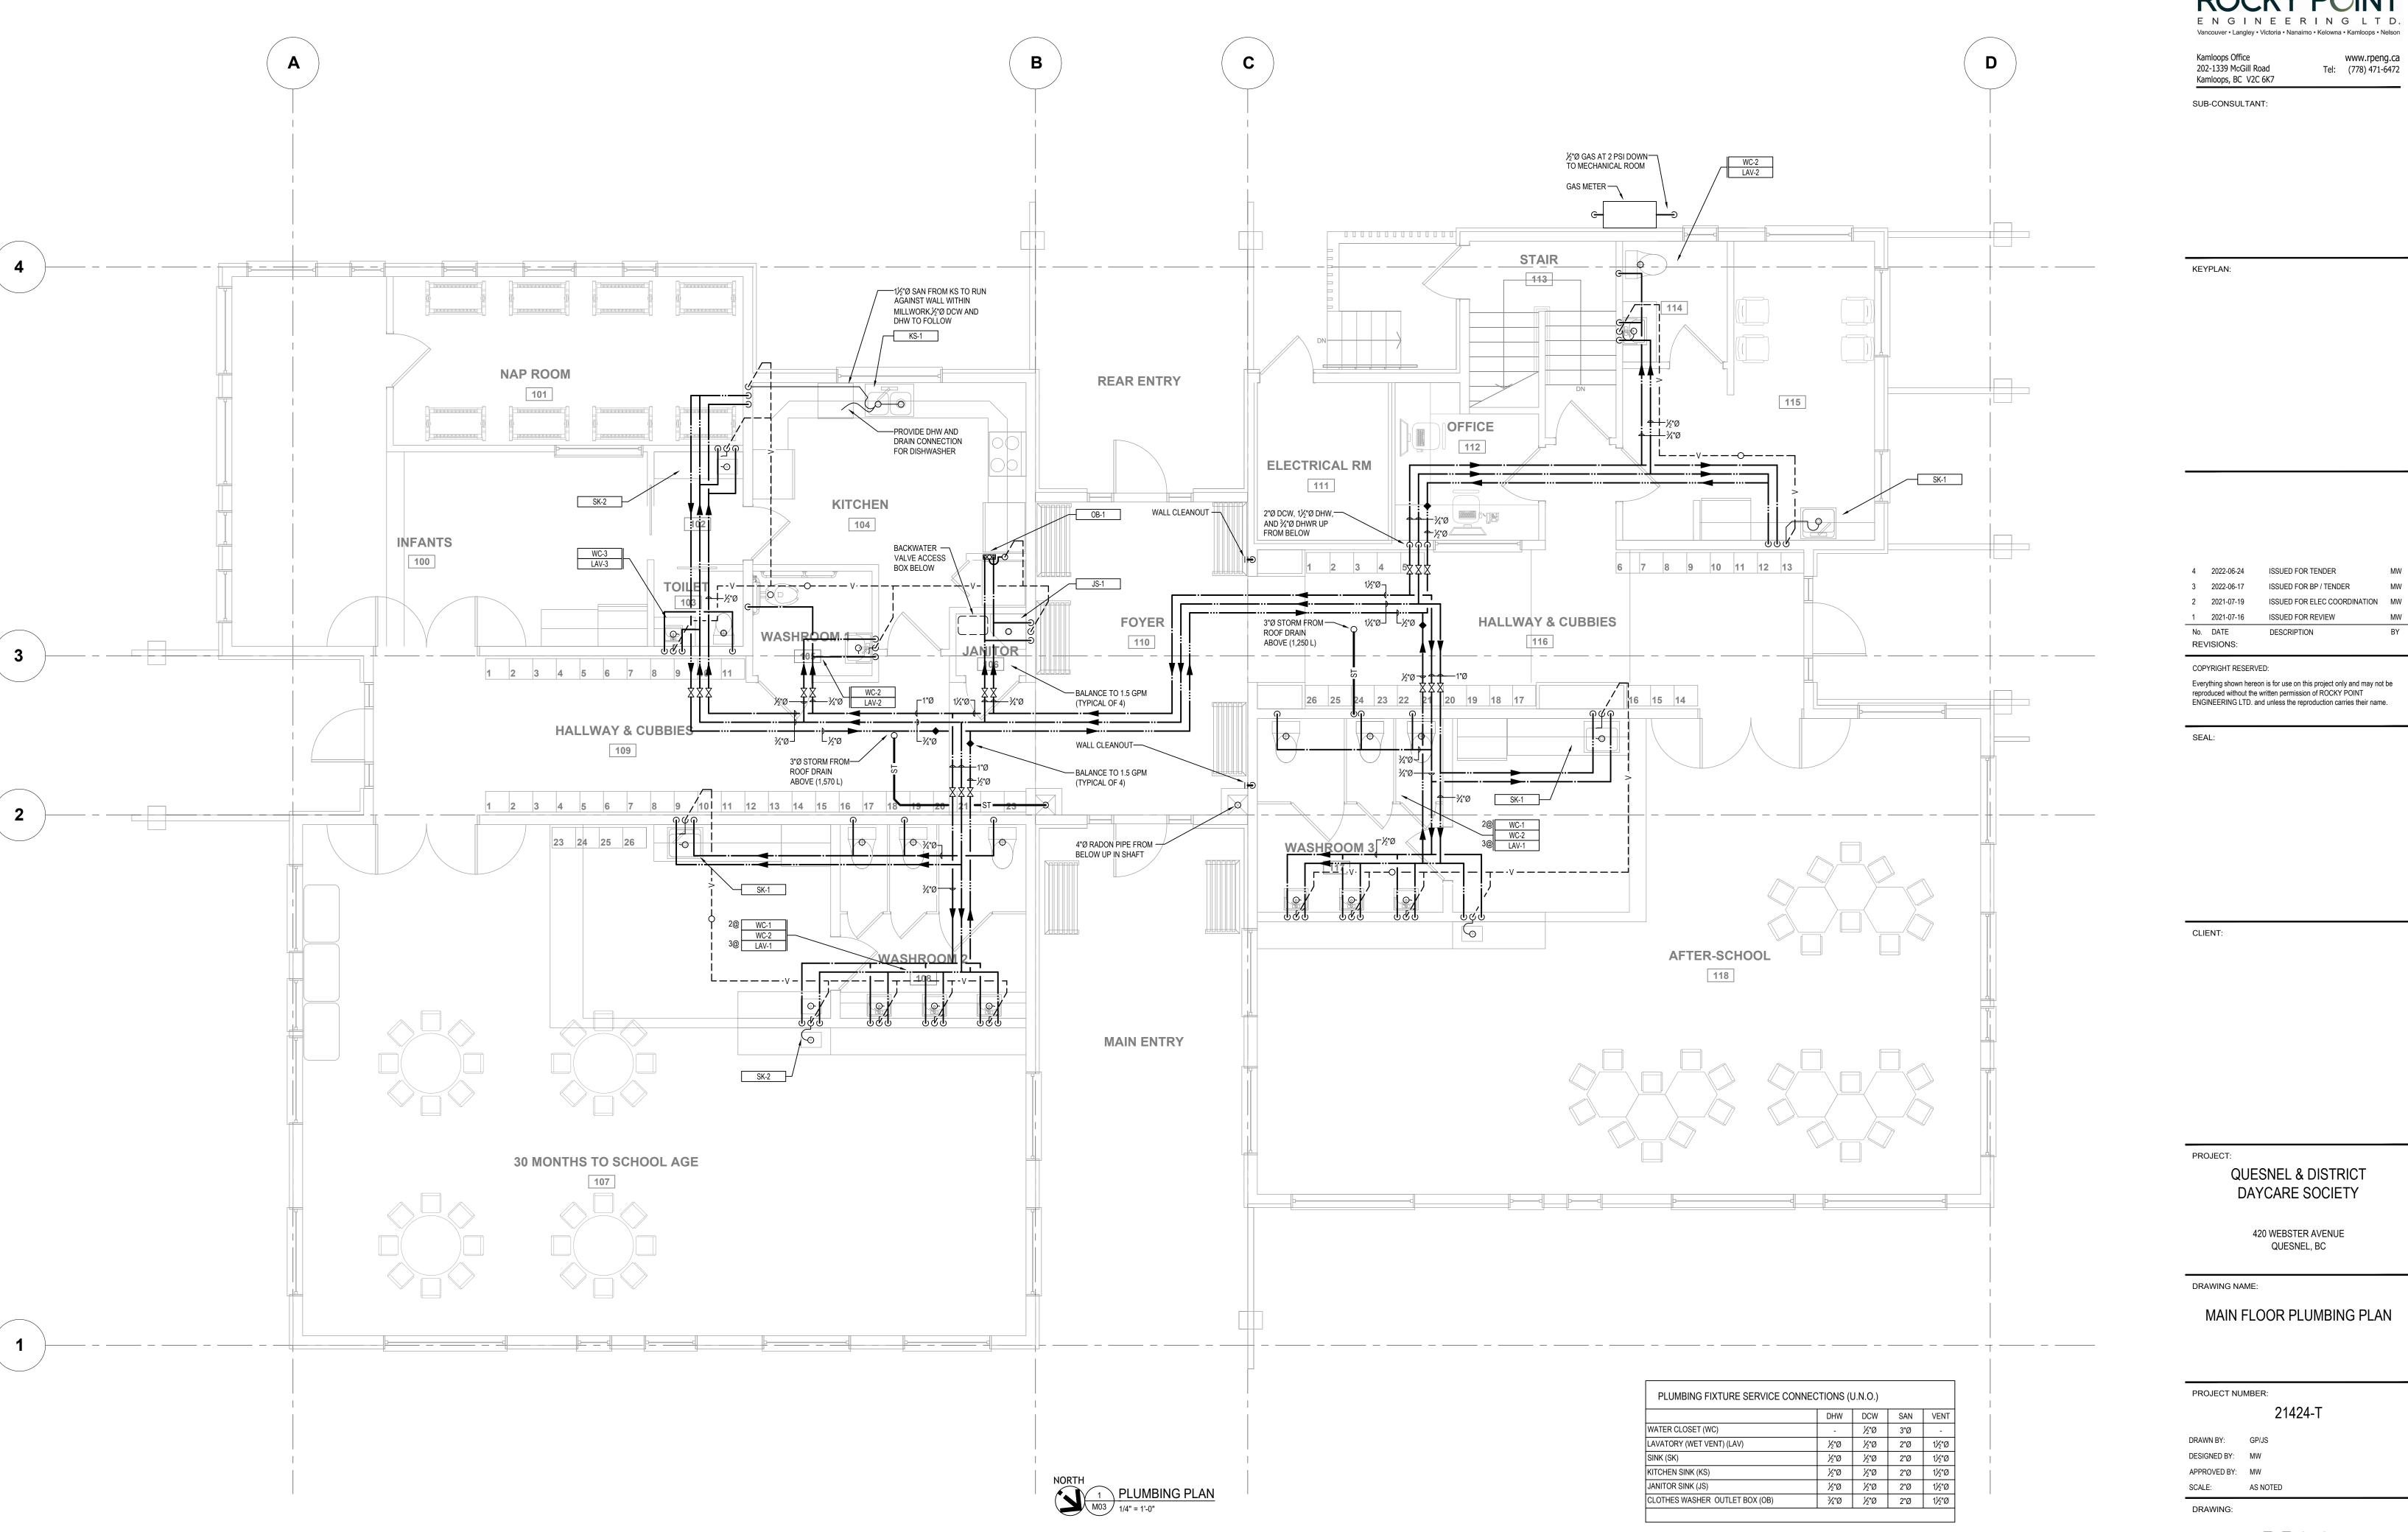


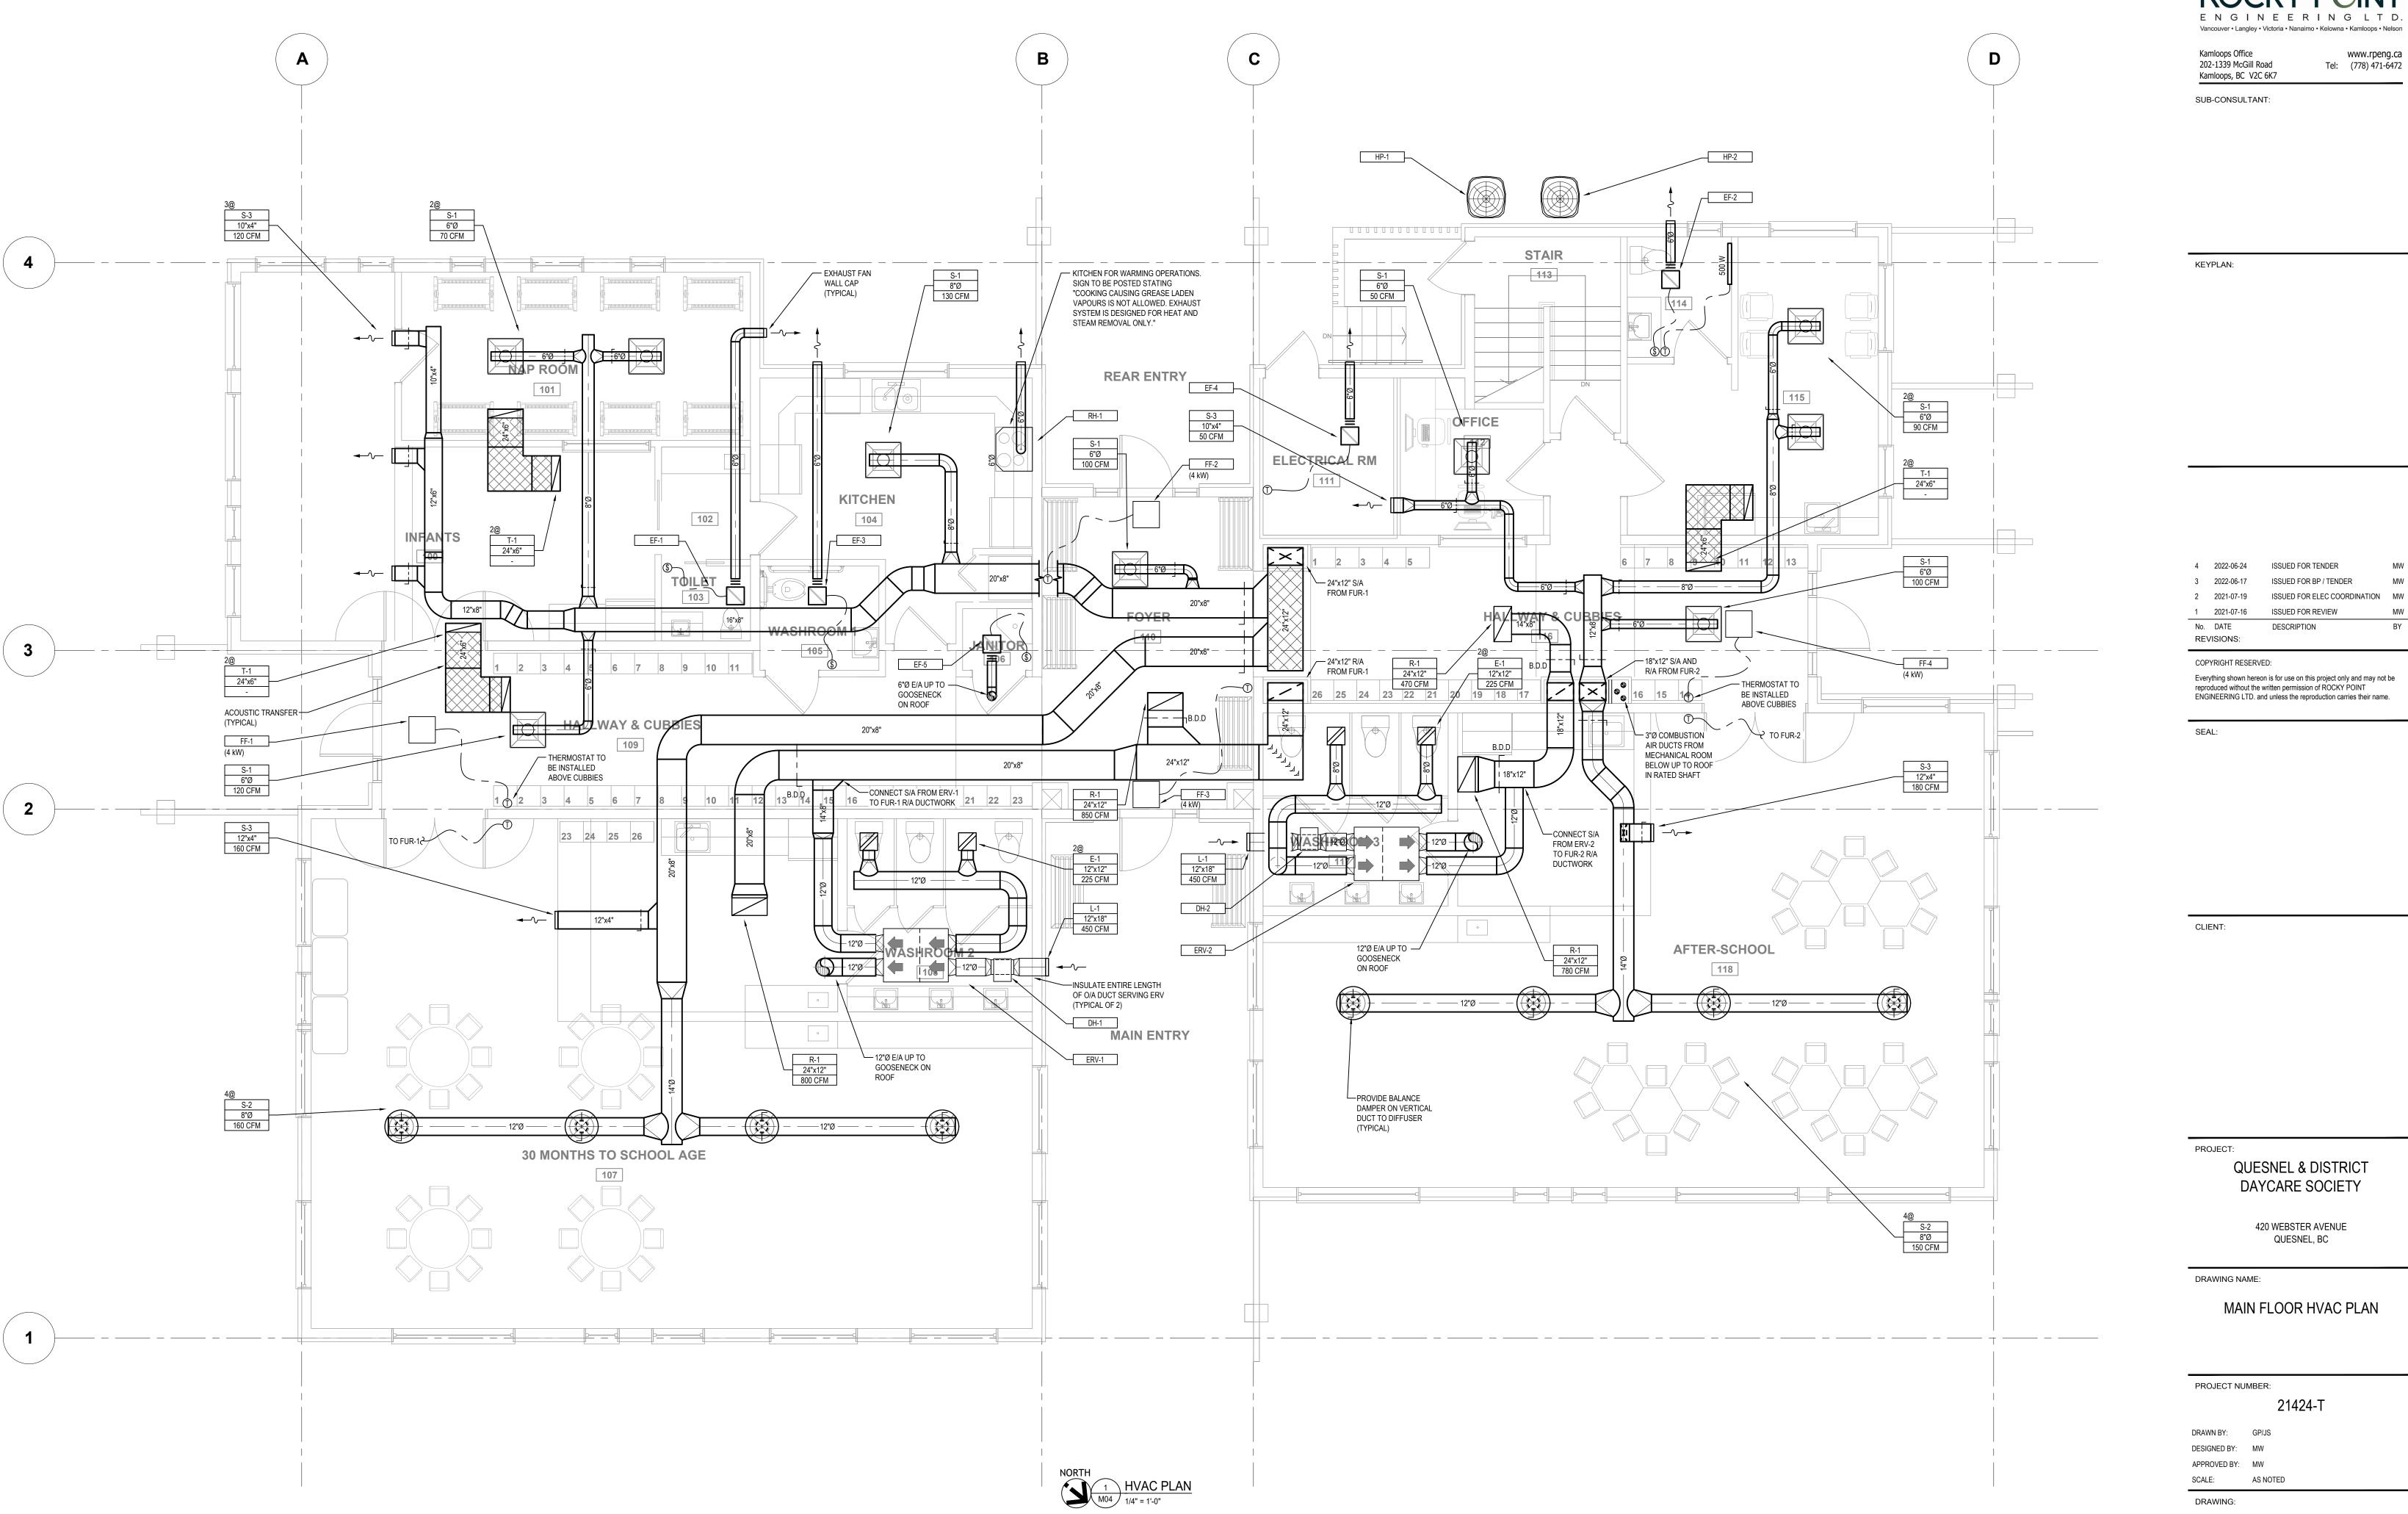
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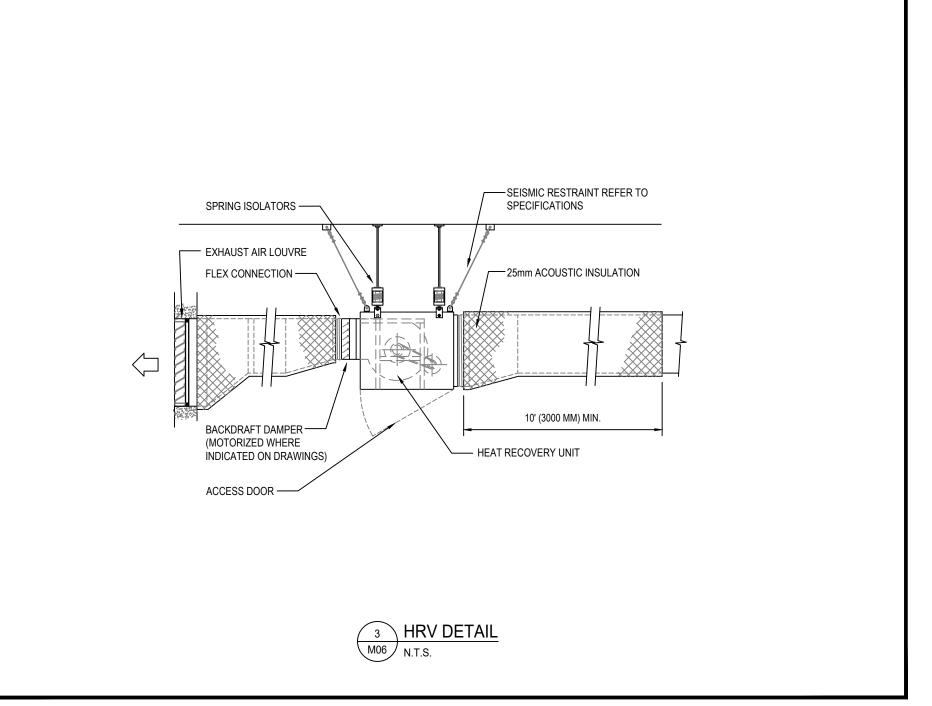
ISSUED FOR ELEC COORDINATION MW

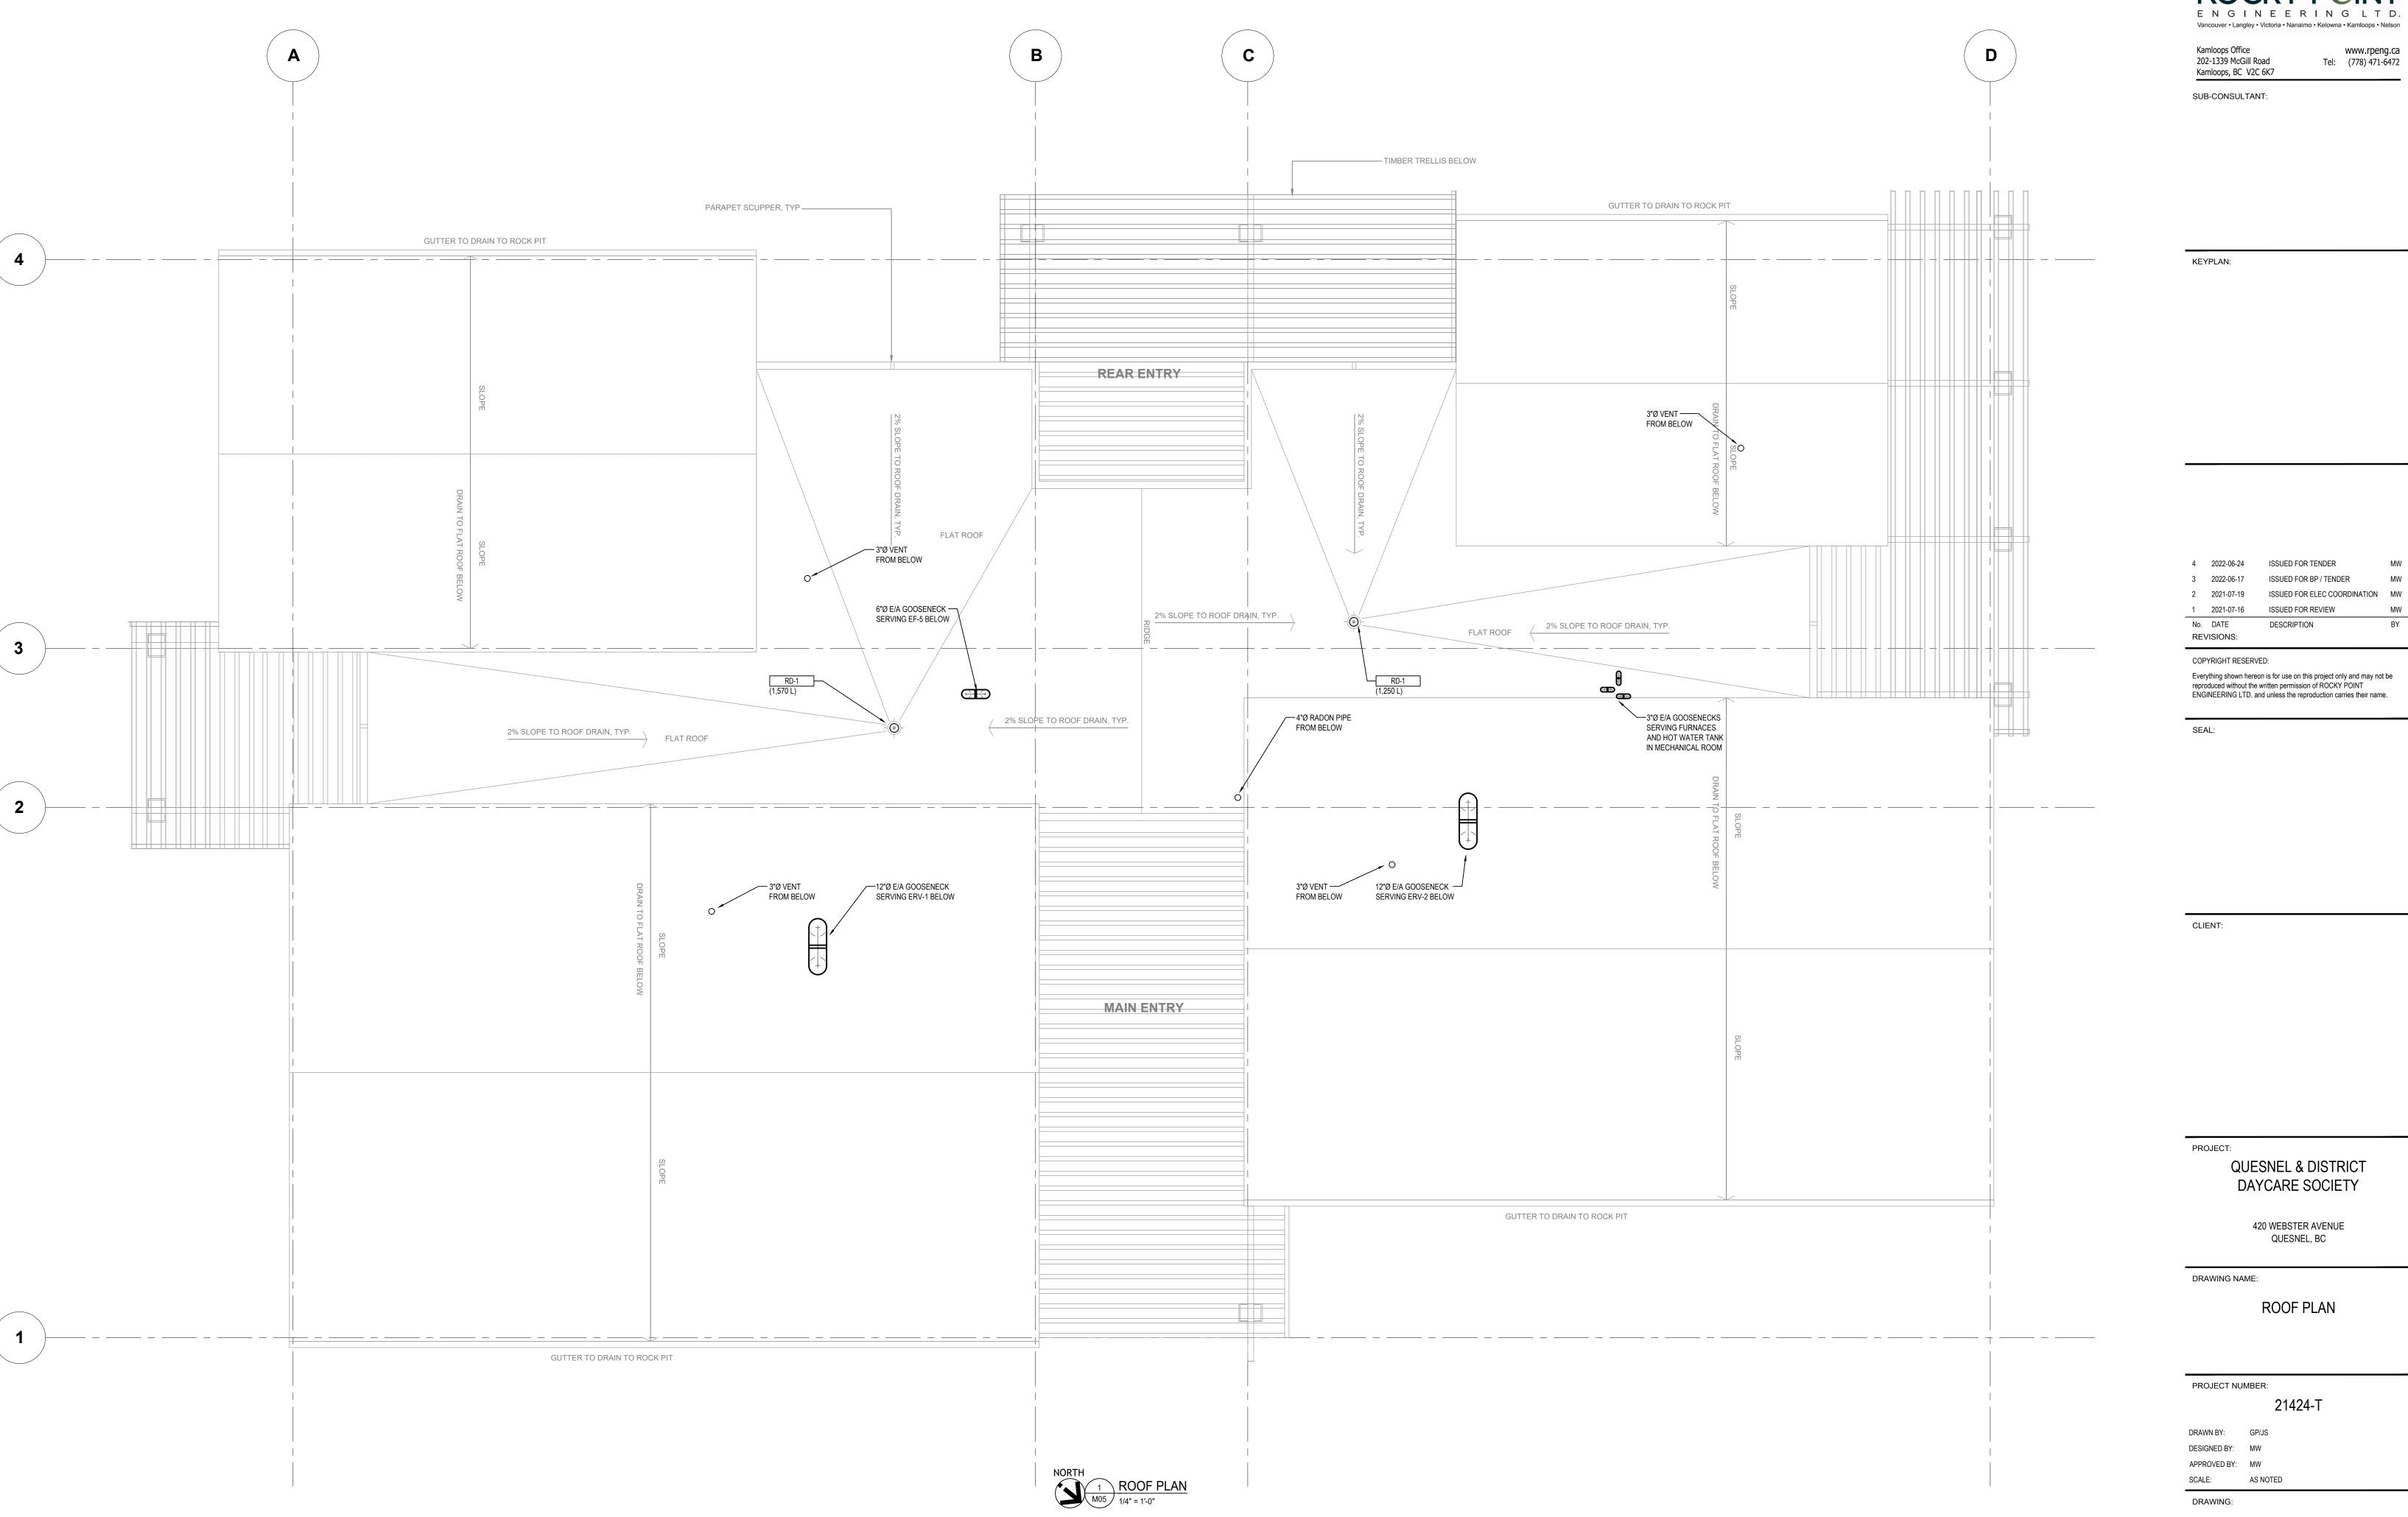



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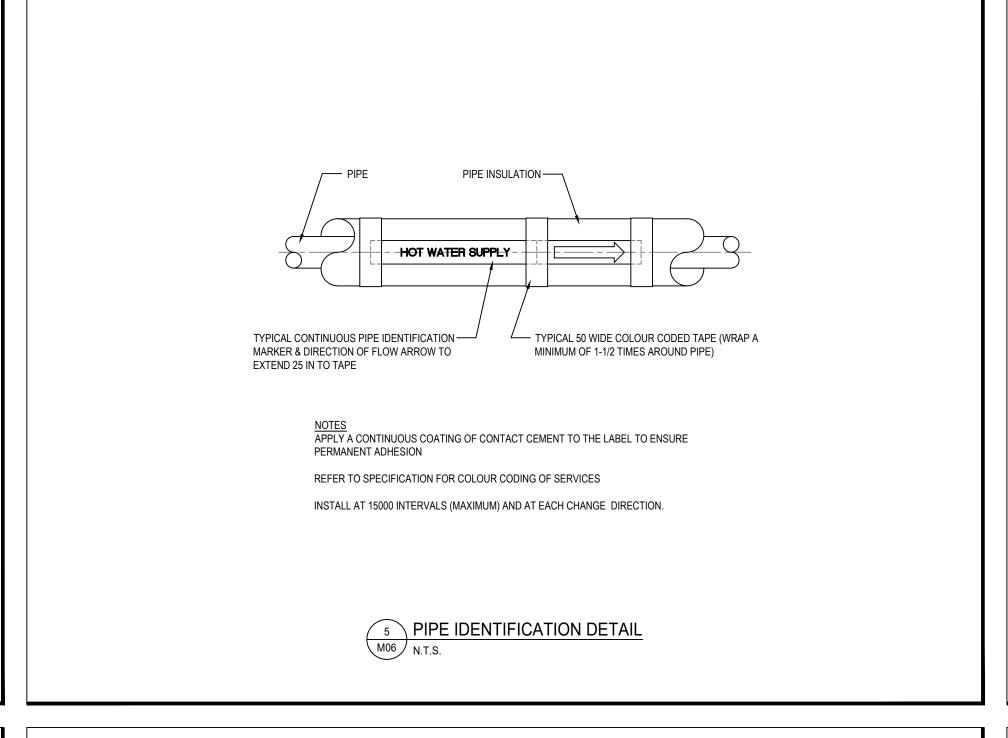





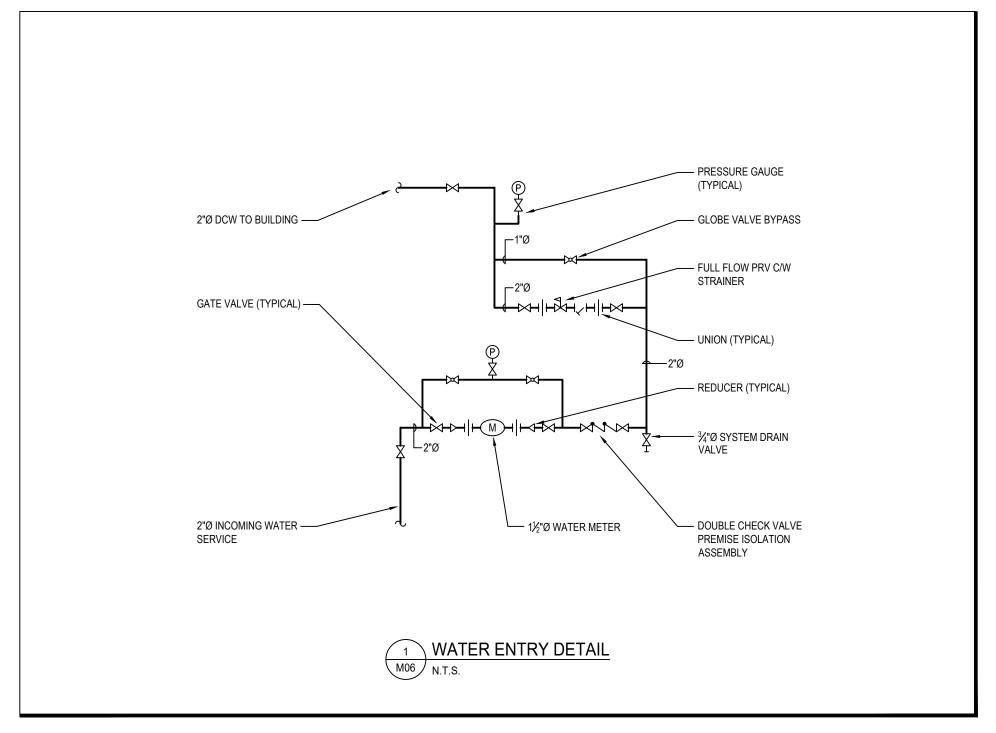


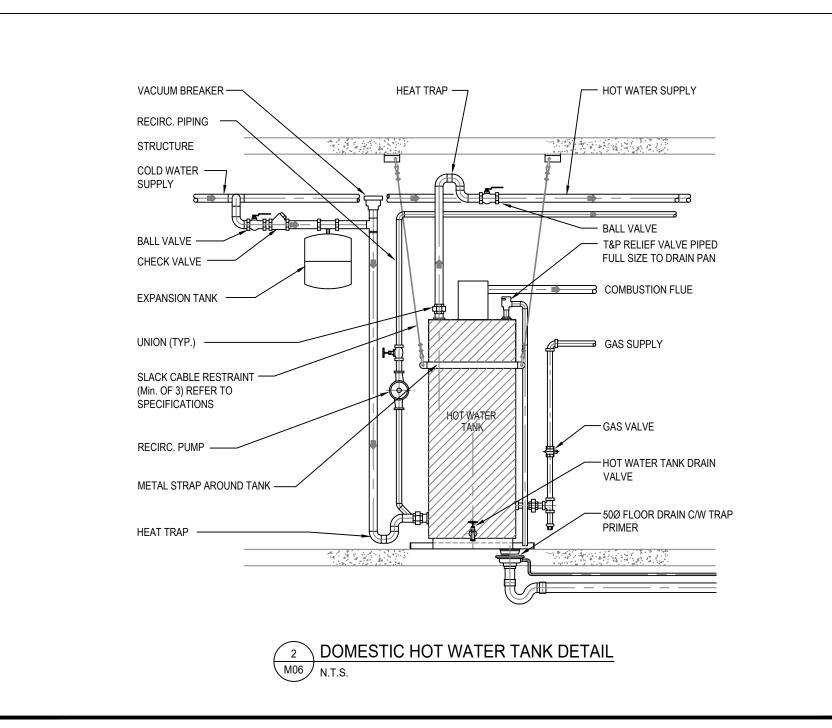


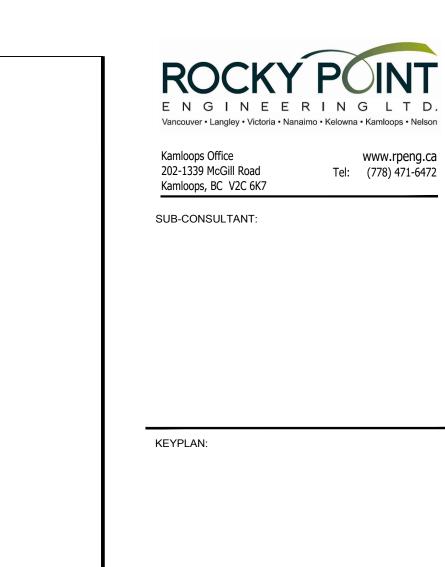


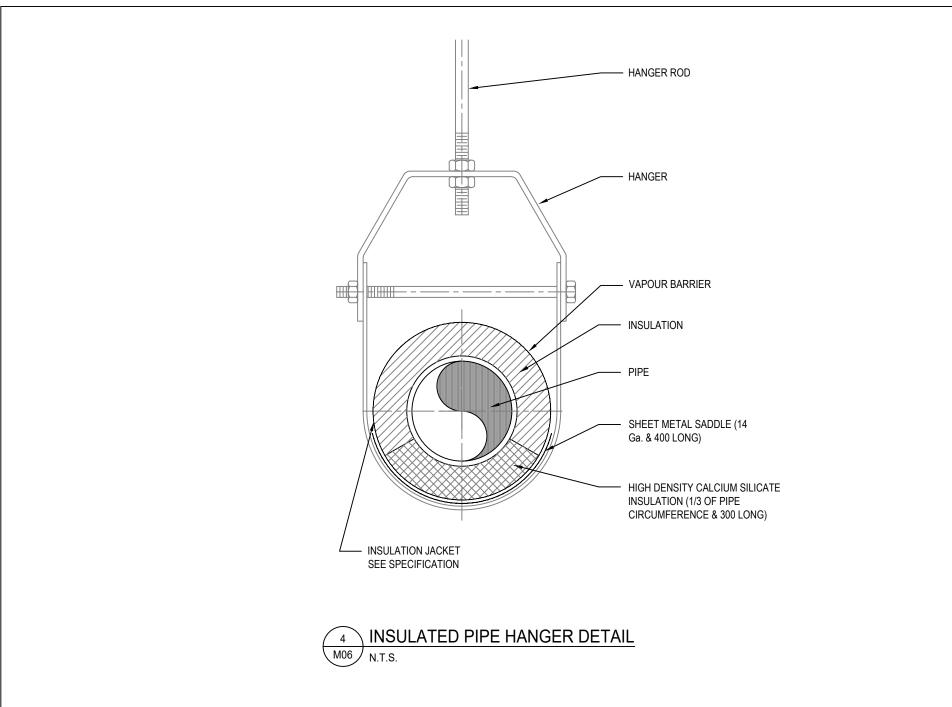


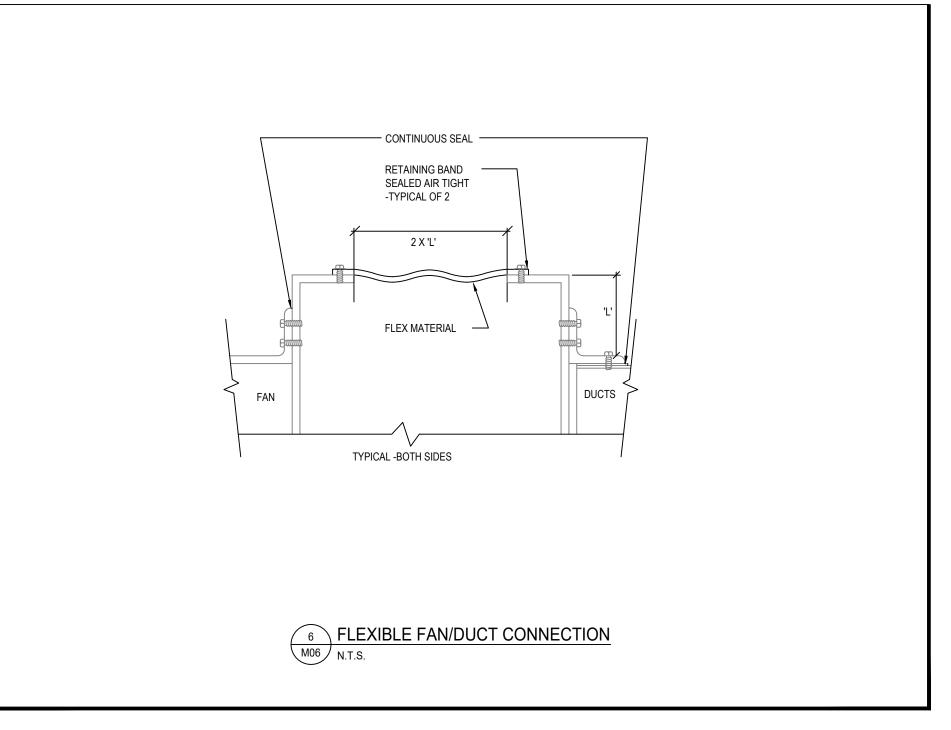

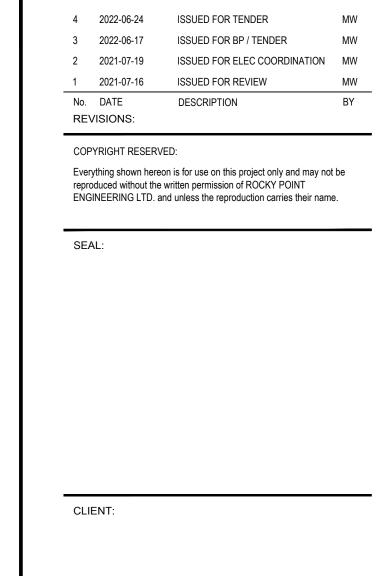

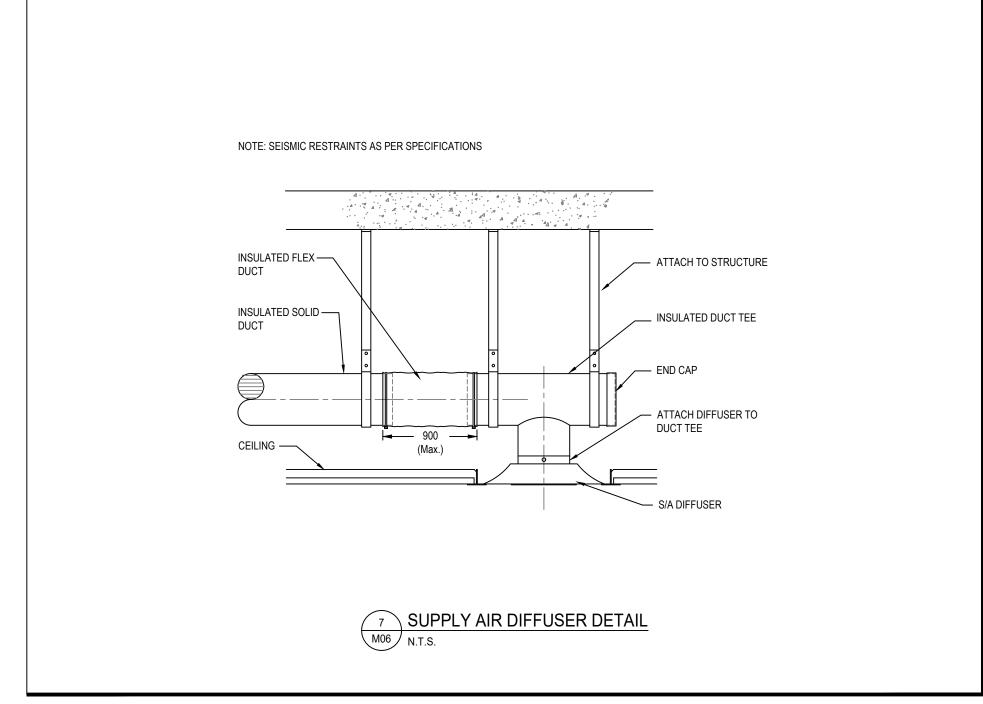

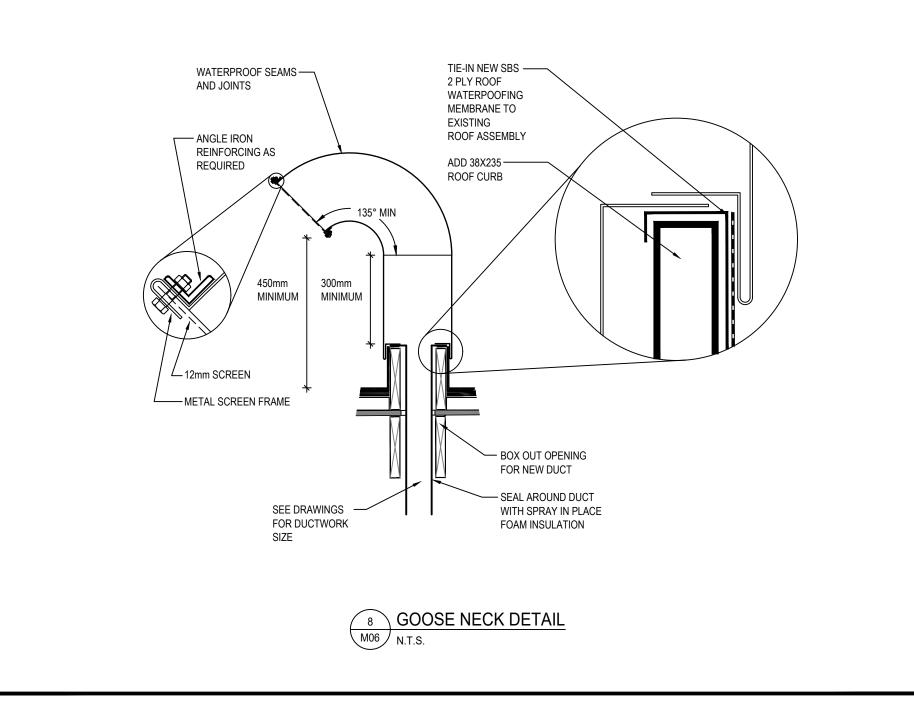

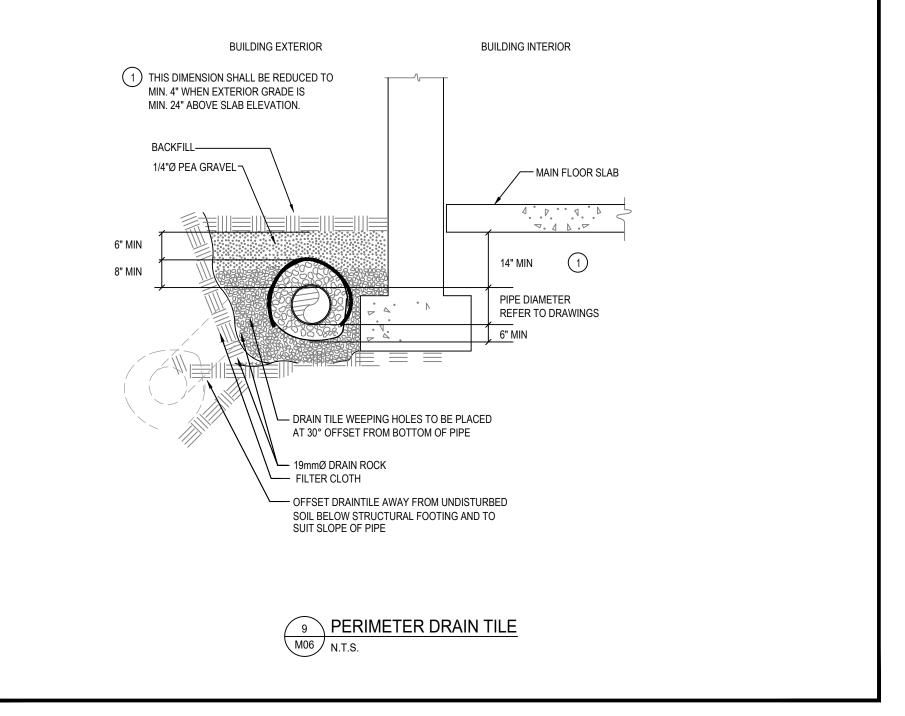

PROJECT:

QUESNEL & DISTRICT

DAYCARE SOCIETY

420 WEBSTER AVENUE QUESNEL, BC

DRAWING NAME:

MECHANICAL DETAILS

21424-T

PROJECT NUMBER:


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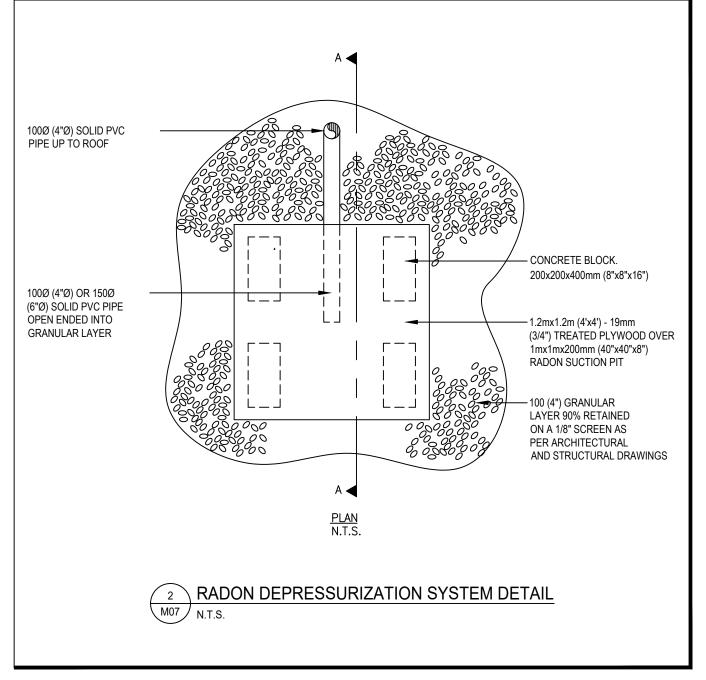
APPROVED BY: MW

SCALE: AS NOTED

DRAWING:

MOTOR LIST																			
ABBREVIATIONS:		STARTERS:	PILOT DE																
M=Mechanical DIV		VSD=Variable speed drive	F=Float S																
E=Electrical DIV 16		MG=Magnetic starter (HOA)	T=Thermo	ostat															
B.A.S.= Building Au	•	MN=Manual starter	P=Pressu	re Switch				ST	ARTE	R		DIS	CONN		PILC)T DE'	VICE		
	Central Control Facility	INT=Integral Starter	C=Time C	Clock				Т	S	I	W	S	I	W	Τ	S	I	W	
EMERG. PWR.=Em	nergency Power		I=Interlock	<				Υ	U	N	I	U	N	ı	Υ	U	N	I	
			S=Manual	l Switch				Р	Р	S	R	Р	S	R	Р	Р	S	R	
SPECIAL INSTRUC	CTIONS		ET-Electro	onic Therm	nostat			E	Р	T	Ε	Р	T	Е	Ε	Р	T	Е	
1.All starters to be n	magnetic H.O.A. unless otherwis	e specified	FA-Fire Al	larm					L	Α	D	L	Α	D		L	Α	D	
2.A terminal section	n shall be provided with all MCC's	S	O=Other						I	L		- 1	L			I	L		
& wired in accordan	nce with standard detail drawing		GS= Gas	Sensor					Ε	L		Е	L			Ε	L		
			B = Buildir	ng Automa	tion Syste	em]	D	Ε		D	Ε			D	Е		
UNIT No.	UNIT DESCRIPTION	LOCATION or ROOM NUMBER	V.	PH	CY	LOAD				D			D				D		REMARKS
ERV-1	Heat Recovery Unit	Preschool WR	120	1	60	MCA 9	15 MOCP 0.6 HP	INT	М	Е	Е	E	E	Е	С	М	Е		Timeclock
ERV-2	Heat Recovery Unit	Afterschool WR	120	1	60	MCA 9	15 MOCP 0.6 HP	INT	M	Е	Ε	E	Е	Е	С	М	Е		Timeclock
DH-1	Duct Heater	Preschool WR	240	1	60	3.5 kW						E	М	Е	T	М	М		SCR Controller & Duct TSTAT
DH-2	Duct Heater	Afterschool WR	240	1	60	3.5 kW						E	M	Е	Т	М	М	Е	SCR Controller & Duct TSTAT
HWT-1	Domestic Hot Water Tank	Mechanical	120	1	60	5 A						E	Е	Е	Т	М	Е	Е	
HWRP-1	Hot Water Recirc Pump	Mechanical Room	120	1	60		2.15 A	I _{INT}	М	М	Ε	ΙĖ	E	Ē	S	E	E		Continuous Operation
I IIWIXI -I	Tiot water recirc r ump	Woonamoar Room	120	'	00	170111	2.10 A	"\"	IVI	IVI	_	-	_	-	O	_	_	-	Continuous Operation
EF-1	Exhaust Fan	Infant WR	120	1	60	80 W		MN	Ε	Ε	Ε	Е	Ε	Ε	S	Ε	Ε	Е	Wire to Wall Switch
EF-2	Exhaust Fan	Staff WR	120	1	60	80 W		MN	Ε	Ε	Ε	Е	Ε	Ε	S	Ε	Ε	Ε	Wire to Wall Switch
EF-3	Exhaust Fan	Accessible WR	120	1	60	80 W		MN	Ε	Ε	Ε	Е	Ε	Ε	S	Ε	Ε	Е	Wire to Wall Switch
EF-4	Exhaust Fan	Electrical Room	120	1	60	80 W		MN	Ε	Ε	Ε	Е	Ε	Е	S	Ε	Ε	Ε	Wire to Reverse Acting Thermostat
EF-5	Exhaust Fan	Janitor Room	120	1	60	80 W		MN	Ε	Ε	Ε	Е	Ε	Ε	S	Ε	Ε	Е	Wire to Wall Switch
RH-1	Rangehood	Kitchen	120	1	60	1.9 A													
FUR-1	Furnace	Mechanical	120	1	60	FLA 10.9	MOCP 15	INT	М	F	Е	E	Е	Е	т	М	Е	Е	
FUR-2	Furnace	Mechanical	120	1	60		MOCP 15	INT	M	E	E	E	E	E	T	M	E	E	
HP-1	Heat Pump Unit	Outside on Pad	240	1	60	MCA 25.8, MOCP 40		INT	M	M	E	E	E	E	T	M	E		Unit Serves FUR-1
HP-2	Heat Pump Unit	Outside on Pad	240	1	60	MCA 20.9, MOCP 35		INT	M	M	E	E	E	E	T	M	E		Unit Serves FUR-2
ΠF-Z	Heat Fullip Offit	Outside on Fad	240	1	00	WICA 20.9, WICCF 3	0, FLA 17.3	""	IVI	IVI	_	-	_	-	1	IVI	_		Offit Serves For-2
SP-1	Sump Pump	Mechanical Room	120	1	60	1/2 HP	8.0 A	INT	М	М	Ε	Е	Ε	Е	F	М	Ε	Е	
STP-1	Storm Sump Pump	Mechanical Room	120	1	60	1/2 HP	8.0 A	INT	М	М	Ε	Е	Ε	Ε	F	М	Ε	Е	
FF-1*	Force Flow Heater	SE Entrance Ceiling				4 kW						_	E	_	т	_	_	_	On Unit
FF-1" FF-2*	Force Flow Heater Force Flow Heater					4 kW						E E	E E	E	T		E E		On Unit
		SW Entrance Ceiling												E	T				On Unit
FF-3* FF-4*	Force Flow Heater Force Flow Heater	NE Entrance Ceiling				4 kW						E	E	E	T T		E		On Unit
FF-4"	Force Flow Heater	NW Entrance Ceiling				4 kW						Е	Ε	Е	ı	Ε	Ε		On Unit
Additional Instructio	ons:	l	1																
* Equipment supplie																			
• • • • • • • • • • • • • • • • • • • •																			



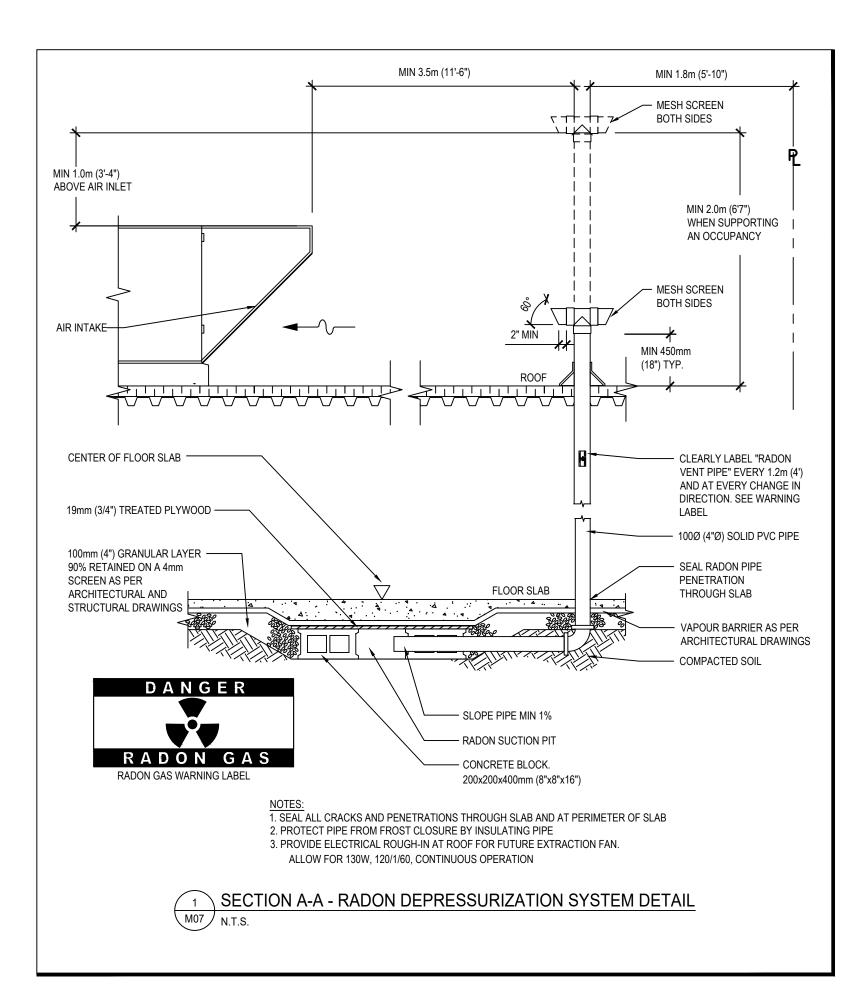



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SUB-CONSULTANT:

ELECTRIC HEA	T SCHEDULE								
UNIT	MANUFACTURER	MODEL	AREA	CAPACITY	DUCT STAT				REMARKS
			SERVED	WATTS	SETPOINT (°F)	V	Ph	Hz	
DH-1	THERMOLEC	RFC-3.5-12x12-240/1	ERV-1	3.5 kW	45	240	1	60	8,9
DH-2	THERMOLEC	RFC-3.5-12x12-240/1	ERV-2	3.5 kW	45	240	1	60	8,9
REMARKS:									
1.	WALL MOUNTED	4.	SEMI RECESSED	7.	BUILT IN T'STAT				
2.	CEILING MOUNTED	5.	SURFACE INSTALL	8.	SCR CONTROLLER	₹			
3.	FULLY RECESSED	6.	WALL T'STAT	9.	DISCHARGE AIR TI	EMP SENS	SOR (INTE	RFACE W	ITH SCR CONTROLLER)

HEAT PUMP SC	CHEDULE									
UNIT	MANUFACTURER	MODEL	DUTY	REFRIGERANT	NOMINAL	VOLTAGE	ELECT.	ELECT.	REMARKS	
NUMBER					TONS	V/PH/HZ	MCA	MOCP		
HP-1	LENNOX	EL16XP1-048	FUR-1	R-410A	4.0	240/1/60	25.8	40	3	
HP-2	LENNOX	EL16XP1-036	FUR-2	R-410A	3.0	240/1/60	20.9	35	3	
REMARKS:								-		
1.	ULTRA LOW AMBIENT UNIT			3. PROVIDE ADVANC	ED PROGRAMMABI	LE THERMOSTAT				
2.	CAPABLE OF COOLING DOW	N TO -32°F		4. PROVIDE WIND GUARDS AS REQUIRED						

UNIT	MANUFACTURER	MODEL	AREA	AIR VOLUME	SP		POWER		REMARKS	
			SERVED	CFM	"	V/Ph/Hz	MCA	HP	1	
ERV-1	RENEWAIRE	EV450IN	FUR-1	450	0.563	120/1/60	9.0	0.6	1,3,9	
ERV-2	RENEWAIRE	EV450IN	FUR-2	450	0.563	120/1/60	9.0	0.6	1,3,9	
EMARKS:										
1.	c/w DAMPER DEFROST	4.	BASIC CONTROL		7.	RECIRCULATION D	EFROST			
2.	2. INTERLOCK RELAY 5.		SCR CONTROLLER		8.	8. WINDSOR 20 MIN. HIGH SPEED TIMER				
3	MERV 13 FILTER	6.	ARCTIC DEFROST MODE		9	TIMECLOCK				

UNIT MARK	MANUFACTURER	MODEL	SERVICE	NOMINAL	CONNECTION	FINISH	MOUNTING	REMARKS
				SIZE	SIZE			
S-1	PRICE	SPD	SUPPLY	24"x24"	SEE DWG	B12	T-BAR OR SURFACE	
S-2	PRICE	RPD	SUPPLY	SEE DWG	SEE DWG	B12	DUCT	
S-3	PRICE	520/F/L/A	SUPPLY	SEE DWG	SEE DWG	B12	SURFACE	
R-1	PRICE	80	RETURN	SEE DWG	SEE DWG	B12	T-BAR OR SURFACE	•
E-1	PRICE	80	EXHAUST	SEE DWG	SEE DWG	B12	T-BAR OR SURFACE	
T-1	PRICE	80	TRANSFER	SEE DWG	SEE DWG	B12	T-BAR OR SURFACE	_
L-1	PRICE	DE635	SUPPLY	SEE DWG	SEE DWG	B12	SURFACE	

UNIT				PUMP		MOTOR		SHIPPING	
NUMBER	MANUFACTURER	MODEL	DUTY	CAPACITY	HEAD	HP	V/PH/HZ	WEIGHT	REMARKS
				(GPM)	(FT.)				
HWRP-1	GRUNDFOS	UPS 26-99	DOMESTIC WATER RECIRC	6	30	FRACT.	120/1/60	10.3	1,2
STP-1	ZOELLER	900-0001	DRAINTILE SUMP PUMP	30	10	1/3	120/1/60	55	1,5,9,11,16
SP-1	ZOELLER	900-0001	LIFT SUMP PUMP	30	10	1/3	120/1/60	55	1,5,9,11,16
MARKS:									

3. FLANGED PUMP CONNECTIONS 4. BRONZE IMPELLER, FULLY ENCLOSED, KEYED TO SHAFT

5. CARBON ROTATING SEAL AGAINST A STATIONARY CERAMIC SEAT

6. SUCTION DIFFUSER c/w STAINLESS STEEL STRAINER AND STABILIZING GUIDE VANES, FLANGED CONNECTIONS

7. TRIPLE DUTY VALVE c/w NON SLAM CHECK AND EFFECTIVE THROTTLING WITH FLOW MEASUREMENT CAPABILITY, FLANGED CONNECTIONS

8. HIGH GRADE HEAT TRACED CAST IRON BASEPLATE 9. DRIP PROOF, RESILIENT MOUNT, SLEEVE BEARING MOTOR

10. FOUR LIQUID LEVEL SWITCH IN WATER PROOF FLOAT BULBS WITH SUPPORT WIRING CHANNEL

11. INTEGRAL AUTOMATIC FLOAT CONTROL SYSTEM 12. OIL RESISTANT POWER CORD, REMOTE HIGH WATER AND OVERLOAD ALARM, CHECK VALVES

13. SUPPORT PUMP FROM ADJACENT PIPING

14. PUMP SUITABLE FOR FLUIDS OF 110°C (230° F)

16. FACTORY WALL CAP

8. HIGH EFFICIENCY MOTOR

15. 40% PROPYLENE GLYCOL 16. COMPLETE WITH MODEL CAST IRON 53 PUMP AND 18"x22" DELUXE BASIN.

UNIT							BURNER		SHIPPING			
NUMBER	MANUFACTURER	MODEL	DUTY	EFF	CAPACITY	FUEL	INPUT		WEIGHT	REMARKS		
	1			(%)	GAL	N/P/E	BTUH	AMPS	(LBS)			
HWT-1	BRADFORD WHITE	EF-60T-125E-3N	DOMESTIC WATER HEATING	96	60	N	125,000	15.0	570	1,2,3,4,5,6,8,9,15,18,19,20		
EMARKS:												
1	. SAFTEY SHUT-OFF INTERLOC	KED W/ FLUE DAMPER 8.	DIRECT CONNECTION INTAKE AND EX	(HAUST	15.	MODULATING GAS	S VALVE					
2	. ELECTRONIC IGNITION	9.	TEMP. & PRESSURE RELIEF VALVE		16.	ELECTRONIC MOD	DULATING GAS VALV	/E				
3	. LOW WATER CUT-OFF	10.	TRIDICATOR		17. POWER VENT KIT							
4	. LOW GAS PRESSURE SWITCH	11.	FLUE DAMPER KIT		18. HIGH LIMIT TEMPERATURE CONTROL							
5	5. HIGH GAS PRESSURE SWITCH 12. OPERATING AQUASTAT				19. CONDENSATE NEUTRALIZATION KIT							
6	6. FLOW SWITCH 13. THREE PASS FLUE SYSTEM				20. PROVIDE THERMAL EXPANSION TANK SUITABLE FOR POTABLE WATER							
7	7. SEISMIC RESTRAINTS 14. MAXITROL GAS PRESSURE REGULATING VALVE											

UNIT	MANUFACTURER	MODEL	AREA	VENT & INTAKE	FUEL	INPUT	OUTPUT	AIRFLOW	SP	MOTOR	COOLING		REMARKS
			SERVED	INCHES	N/P	MBH	MBH	CFM	INCHES	FLA	TON	V/Ph/Hz	
FUR-1	LENNOX	EL296UH110XE60C	BUILDING SOUTH	3"	N	110	106	1,650	0.8	10.9	4.0	120/1/60	1,2,3,4,5
FUR-2	LENNOX	EL296UH090XE48C	BUILDING NORTH	3"	N	88	84	1,250	0.8	8.4	3.0	120/1/60	1,2,3,4,5
MARKS:													
1.	C/W EXTERNAL FILTER KIT	3.	5. c/w CONDENSATE NEUTRALIZER										
2.	2. DX COIL TO MATCH w/ FURNACE & HP				4. c/w CONCENTRIC TERMINATION								

UNIT								MOTOR		i l			
NUMBER	MANUFACTURER	MODEL	DUTY	CAPACITY (CFM)	S.P. W.C.	SONES	RPM	LOAD	V/PH/Hz	WEIGHT (LBS)	REMARKS		
EF-1	PANASONIC	FV-05-11VKS1	103 - INFANT WASHROOM	110	0.25	0.8	1,205	0.27	120/1/60	-	2,5,13,14,31		
EF-2	PANASONIC	FV-05-11VKS1	114 - STAFF WASHROOM	110	0.25	0.8	1,205	0.27	120/1/60	-	2,5,13,14,31		
EF-3	PANASONIC	FV-05-11VKS1	105 - ACCESSIBLE WASHROOM	110	0.25	0.8	1,205	0.27	120/1/60	-	2,5,13,14,31		
EF-4	PANASONIC	FV-05-11VKS1	111 - ELECTRICAL ROOM	50	0.25	0.3	1,072	0.27	120/1/60	-	1,4,5,13,14,31		
EF-5	PANASONIC	FV-05-11VKS1	106 - JANITOR	50	0.25	0.3	1,072	0.27	120/1/60	-	1,5,13,14,23,31		
RH-1	BROAN	BU330WW	KITCHEN RANGE HOOD	190		7.0		1.9 A	120/1/60	-	3,5,10,11,16		
2. 3. 4. 5.	WIRE TO WALL SWITCH 9. EPOXY COATED WHEEL AND B.D.D. 2. 20/40/60 MINUTE TIMER WALL SWITCH 10. FACTORY LIGHT 7" ROUND CONNECTION WIRE TO REVACTING THERMOSTAT BACKDRAFT DAMPERS 13. POLYPROPYLENE CONSTRUCTION 6. ACOUSTIC LINED CABINETS 14. DISCONNECT SWITCH				18 19 20 21 22	CO / GAS DETECT LINT TRAP HEAT SENSOR CO FANTECH 7" LD DU SOLID STATE SPE MOTOR GUARD FAN TO RUN CON	ONTROL JCT SILENCER ED CONTROL	26 27 28 29 30	25. UPBLAST DISCHARGE. 26. C/W WEATHERHOOD 27. C/W ACCESS DOOR 28. C/W 1" DRAIN CONNECTION 29. INTERLOCK W/ MOTORIZED DAMPER 30. INTERLOCK W/ KITCHEN MAKE-UP AIR UNIT D 31. NO ALTERNATE ACCEPTED				

24. CONTINUOUS OPERATION

32. DDC CONTROL

KEYPLAN:

4 2022-06-24 ISSUED FOR TENDER 3 2022-06-17 ISSUED FOR BP / TENDER 2 2021-07-19 ISSUED FOR ELEC COORDINATION MW 1 2021-07-16 ISSUED FOR REVIEW No. DATE DESCRIPTION **REVISIONS:**

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SEAL:

CLIENT:

PROJECT:

QUESNEL & DISTRICT DAYCARE SOCIETY

> 420 WEBSTER AVENUE QUESNEL, BC

DRAWING NAME:

MECHANICAL SCHEDULES

21424-T

PROJECT NUMBER:

DRAWN BY: DESIGNED BY: MW

APPROVED BY: MW SCALE: AS NOTED DRAWING: